

FLOOR PLAN GENERAL NOTES

1.GAS LIN

GAS PIPING PLACED UNDER ANY CONCRETE SLAB SHALL COMPLY PER IFGC 404.14 REQUIREMENTS.
 SHALL CONFORM TO IFGC SECTION 403 FOR MATERIALS, INSTALLATION, AND TESTING.

2. VERIFY AND MAINTAIN REQUIRED HORIZONTAL AND VERTICAL CLEARANCES ABOVE THE FINISHED COUNTERTOP SURFACE BEFORE ORDERING OR INSTALLING CABINETS.

3. MAXIMUM STUD SPACING IS 16 INCHES ON CENTER UNLESS NOTED OTHERWISE

4. REFER TO STRUCTURAL DRAWINGS FOR LOCATIONS AND ADDITIONAL REQUIREMENTS FOR LOAD-BEARING AND SHEAR WALLS


5. TYPICAL GYPSUM SHEATHING THICKNESS IS 5/8 INCH UNLESS NOTED

6. PROVIDE A LISTED AND APPROVED RANGE OR COOKTOP UNIT AND INSTALL PER MANUF. REQUIREMENTS. RANGES AND COOKTOPS ARE TO BE MANUFACTURER WOLF OR SIMILAR.

FLOOR PLAN KEYNOTES


- 1. PROVIDE TILE SURFACE AT WALLS SHOWN WITH BOLD DASHED LINE PER *IRC R708.2*. TILE SURFACE SHALL EXTEND A MINIMUM OF 6 FEET ABOVE FINISHED FLOOR HEIGHT.
- 2. PROVIDE 1-RATED WALL ASSEMBLY AS NOTED. REFER TO RATED WALL ASSEMBLY DETAIL 12 ON SHEET A502.
- 3. OVERHANG OF ROOF FROM LEVEL ABOVE.4. ALL WEATHER LANDING SURFACE EQUAL IN WIDTH TO THE
- DOOR SERVED AND MIN. 36" DEEP IN DIRECTION OF TRAVEL AT ALL EXTERIOR DOORS PER *IRC R311.3.*
- 5. 36" MIN. HEIGHT GUARDRAIL W/ 4" MAX VERTICAL SPACING OF HORIZONTAL RUNGS. GUARDRAIL TO SUPPORT 200# CONCENTRATED LOAD / 50# UNIFORM LOAD PER 2018 IRC R312.1.
- **6.** PROVIDE CONTINUOUS 1-1/2" DIA. HANDRAIL @ 36" A.F.F. PER *IRC R311.7*.
- 7. STAIR RISER HEIGHT SHALL BE A MAXIMUM OF 7-3/4" MEASURED VERTICALLY BETWEEN LEADING EDGES OF ADJACENT TREADS PER IRC R311.7.
- 8. OPEN RISERS CANNOT PERMIT THE PASSAGE OF A 4" SPHERE BETWEEN TREADS PER IRC *R311.7*.
- 9. MIN. STAIR TREAD DEPTH IS 10" MEASURED HORIZONTALLY BETWEEN VERTICAL PLANES OF THE FOREMOST PROJECTION
- OF ADJACENT TREADS PER *IRC R311.7.*10. PROFILE OF TREAD: RADIUS OF LEADING EDGE OF TREAD SHALL BE NO GREATER THAN 9/16. A NOSING NOT LESS THAN
- 3/4 BUT NOT MORE THAN 1 1/4 SHALL BE PROVIDED ON STAIRWAYS WITH SOLID RISERS PER *IRC R311.7*.
 11. GAS FIREPLACE INSTALL PER *IRC R1004 AND R1005* COMBUSTION AIR PROVIDED PER *IRC R1006*.
- REFER TO FIREPLACE SPECS ON SHEET A503.12a. METAL ROOF SCUPPER W/ DOWNSPOUT.
- 12b. 4" X 6" MIN. THRU-WALL SCUPPER.
- 13. TANKLESS GAS WATER HEATER. SEE PLUMBING.
- 14. HEAT PUMP. SEE MECHANICAL.
- **15.** TRASH / RECYCLING BINS.
- **16.** GAS METER. SEE PLUMBING.
- 17. 400 AMP ELECTRICAL PANEL. SEE ELECTRICAL.18. AIR HANDLER. SEE MECHANICAL.
- 19. SOFT WATER LOOP.
- 20. WATER SOFTENER EQUIPMENT.
- **21.** 4" DIAMETER CONDUIT FROM ELECTRICAL PANEL TO ROOF FOR FUTURE SOLAR ARRAY. SEE ELECTRICAL.
- 22. 2" FLOOR DRAIN W/ LEADER DOWN TO LOWER LEVEL. NOT TO BE CONNECTED TO SEWER SYSTEM.
- 23. INTERNAL GUTTER.
- **31.** WATERPROOF DECKING SYSTEM ICC-ES REPORT ESR-2201.
- **42.** POLY-DECK 150 PER ICC-ES REPORT ESR-2785 W/ LOW-PROFILE PEDESTAL LEVELING SYSTEM.
- **44.** DECORATIVE 2"X6", OR SIMILAR, HEMLOCK SHADE FINS.

FLOOR PLAN LEGEND

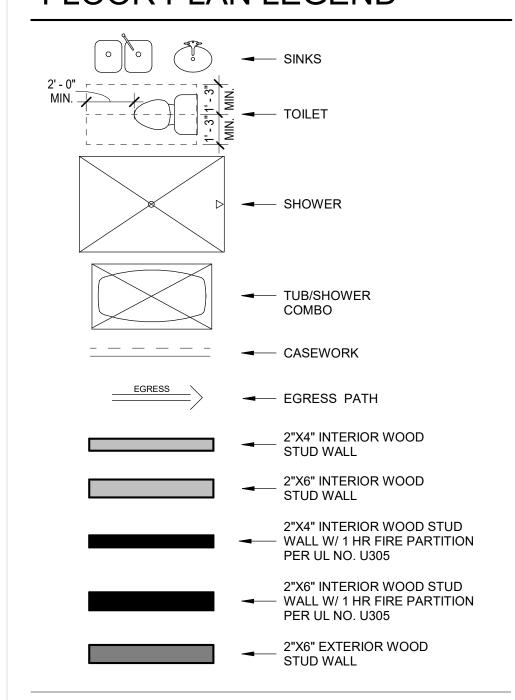

NOTES:

- ALL WOOD FRAMED EXTERIOR WALLS TO HAVE MIN. R-21 INSULATION TYP. ALL CEILINGS TO HAVE MIN. R-38 INSULATION TYP.
 - 90% OF LAMPS IN PERMANENT FIXTURES OR 90% OF PERMANENT FIXTURES HAVE HIGH EFFICACY LAMPS. DOES NOT APPLY TO LOW VOLTAGE LIGHTING
- CLOTHES DRYERS TO HAVE BOTH GAS AND ELECTRIC HOOKUP OPTIONS. REFERENCE SHEET P103 AND E104.

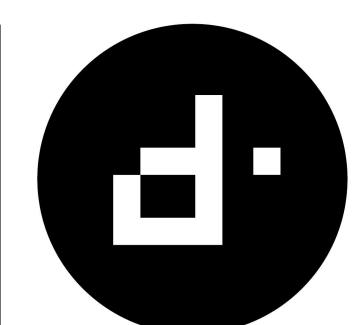

DESIGN**TANK** ©


1640 E BETHANY HOME ROAD PHOENIX, AZ 85016 503.580.5626

CONSULTANT:

PERMIT SET

MAIRE - LOT 4

EVISION DATE REASON FOR ISSUE

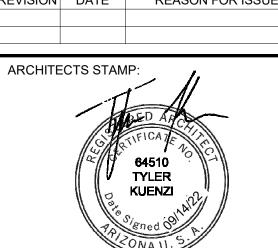

FLOOR PLAN -LEVEL 1


DATE 2022-0914

SCALE SHEET NUMBER 1/4" = 1'-0"

SHEET SIZE

30" X 42"

A103

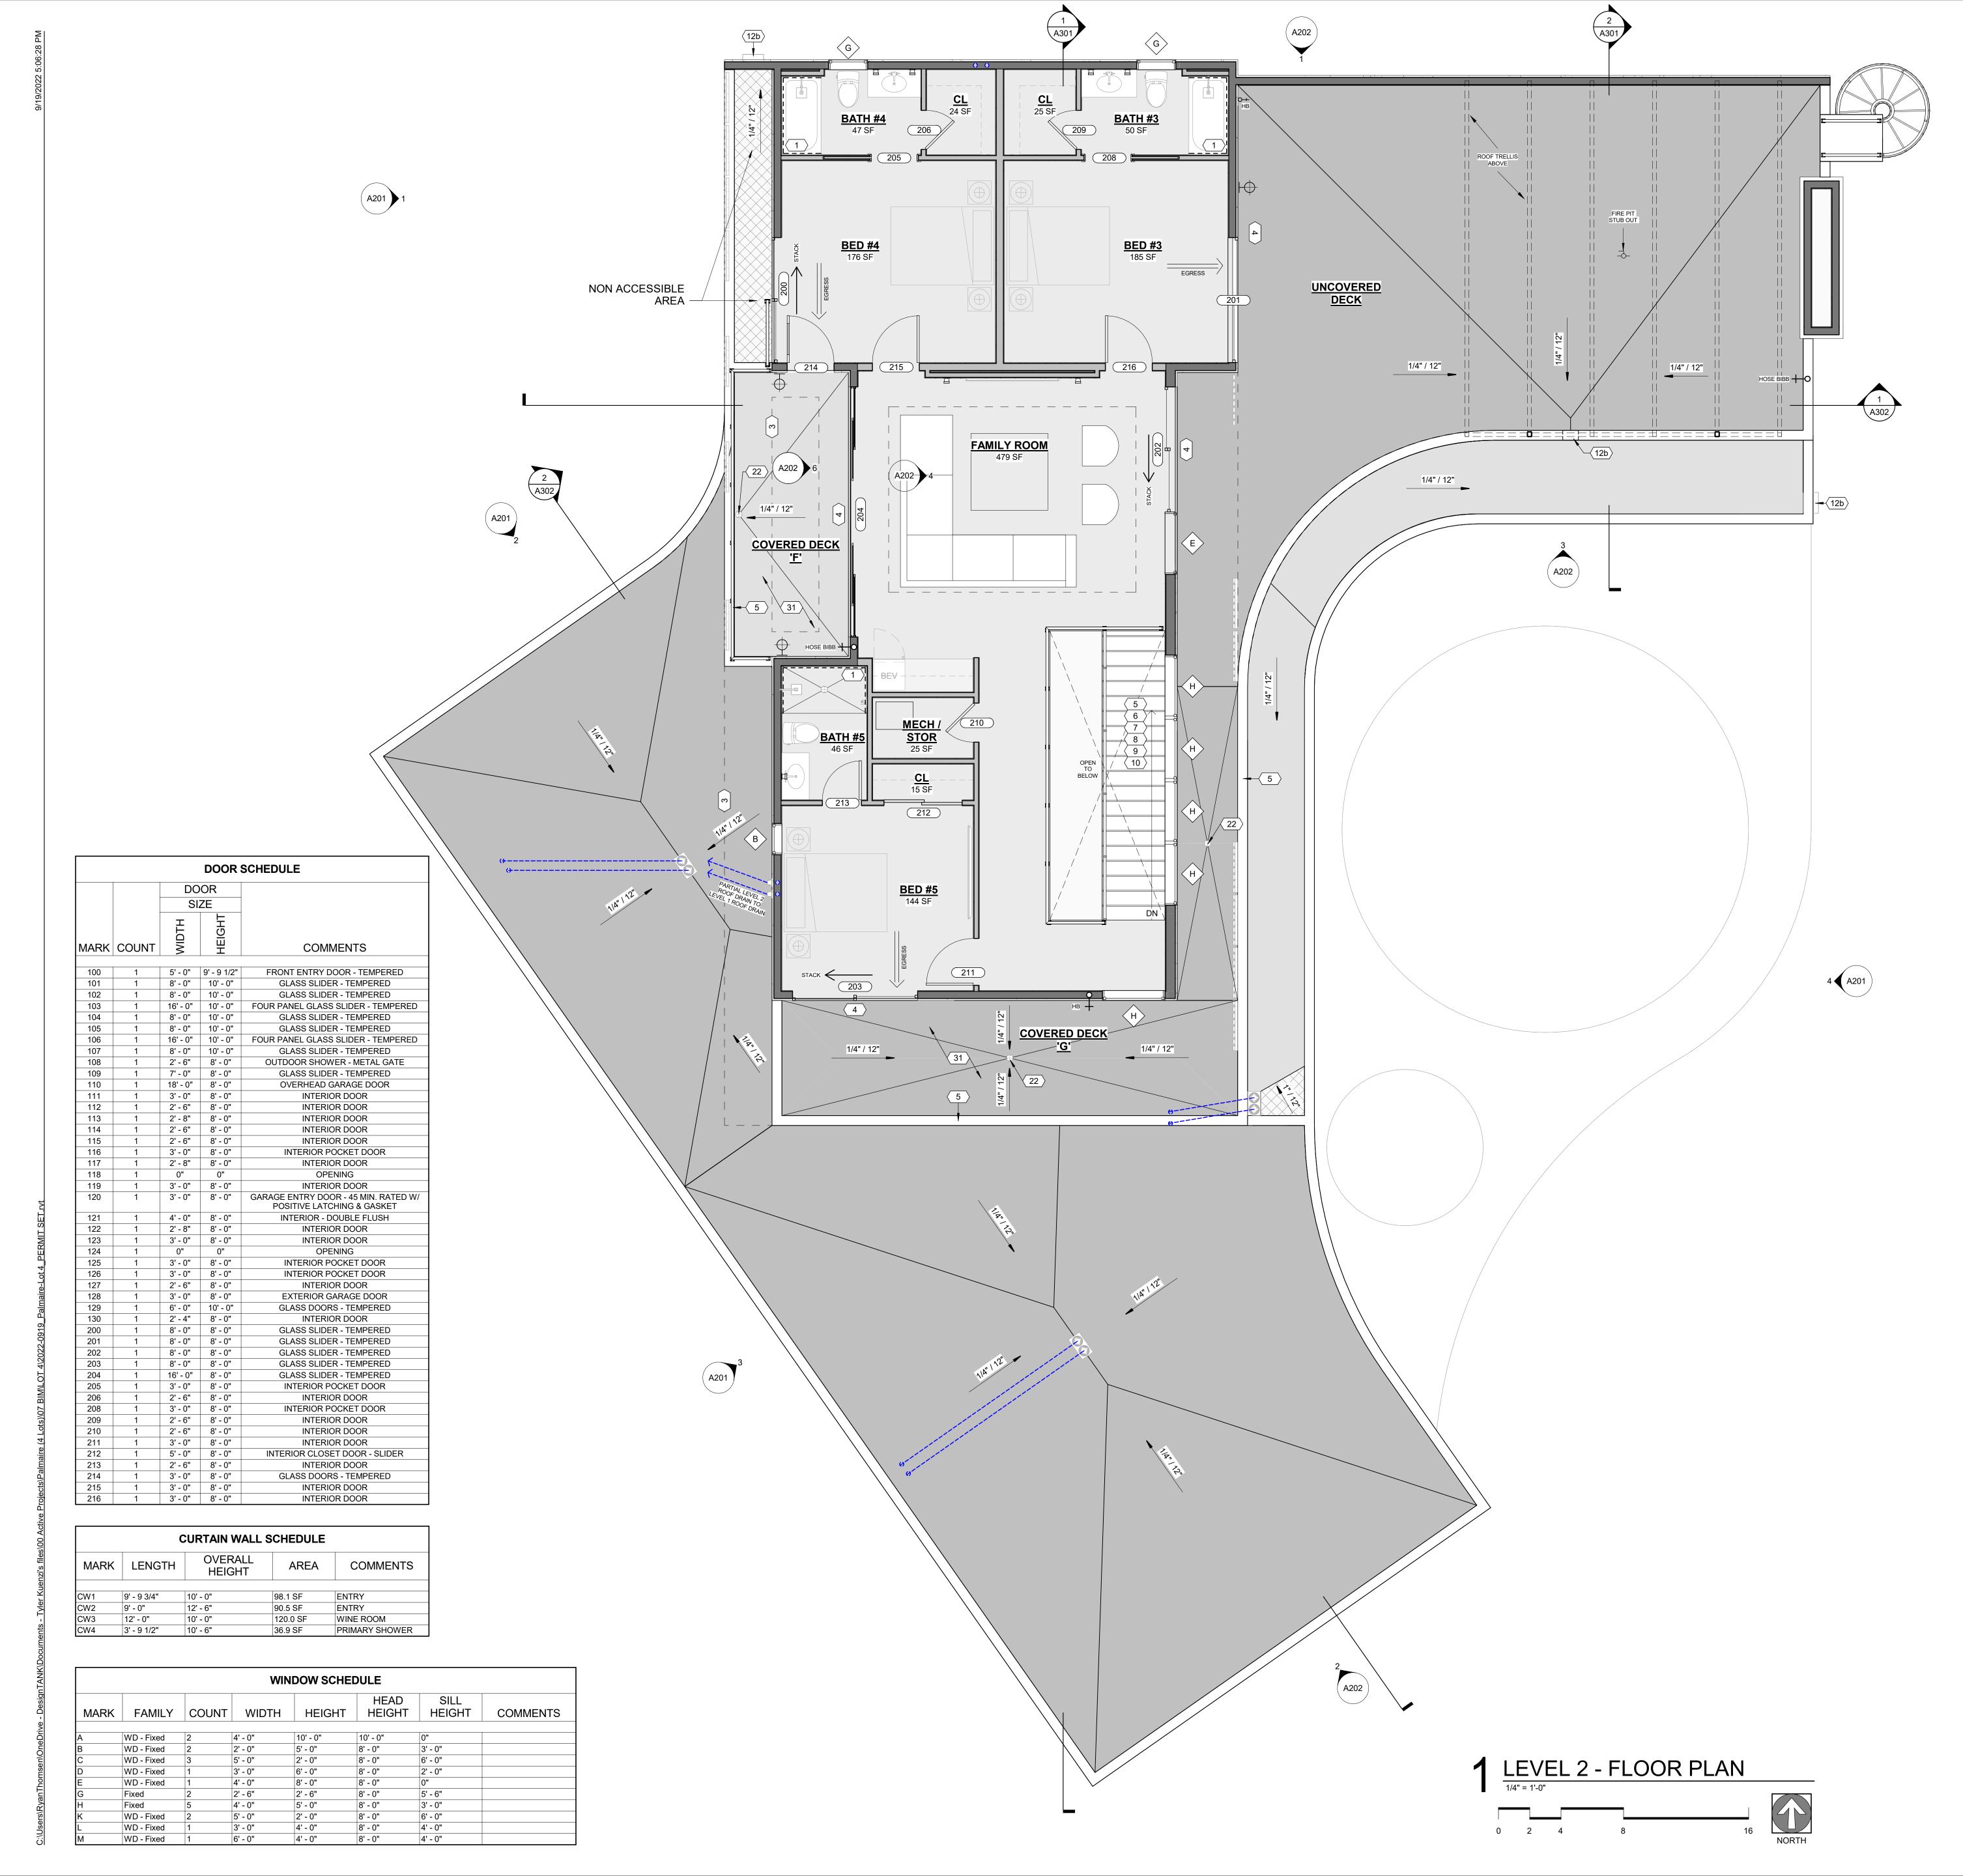

FLOOR PLAN GENERAL NOTES

GAS PIPING PLACED UNDER ANY CONCRETE SLAB SHALL COMPLY PER IFGC 404.14 REQUIREMENTS. SHALL CONFORM TO IFGC SECTION 403 FOR MATERIALS, INSTALLATION, AND TESTING.

2. VERIFY AND MAINTAIN REQUIRED HORIZONTAL AND VERTICAL CLEARANCES ABOVE THE FINISHED COUNTERTOP SURFACE BEFORE ORDERING OR INSTALLING CABINETS.

3. MAXIMUM STUD SPACING IS 16 INCHES ON CENTER UNLESS NOTED OTHERWISE

4. REFER TO STRUCTURAL DRAWINGS FOR LOCATIONS AND ADDITIONAL REQUIREMENTS FOR LOAD-BEARING AND SHEAR WALLS 5. TYPICAL GYPSUM SHEATHING THICKNESS IS 5/8 INCH UNLESS NOTED

6. PROVIDE A LISTED AND APPROVED RANGE OR COOKTOP UNIT AND INSTALL PER MANUF. REQUIREMENTS. RANGES AND COOKTOPS ARE TO BE MANUFACTURER WOLF OR SIMILAR.


FLOOR PLAN KEYNOTES

- 1. PROVIDE TILE SURFACE AT WALLS SHOWN WITH BOLD DASHED LINE PER IRC R708.2. TILE SURFACE SHALL EXTEND A MINIMUM OF 6 FEET ABOVE FINISHED FLOOR HEIGHT.
- 2. PROVIDE 1-RATED WALL ASSEMBLY AS NOTED. REFER TO RATED WALL ASSEMBLY DETAIL 12 ON SHEET A502.
- 3. OVERHANG OF ROOF FROM LEVEL ABOVE.
- 4. ALL WEATHER LANDING SURFACE EQUAL IN WIDTH TO THE DOOR SERVED AND MIN. 36" DEEP IN DIRECTION OF TRAVEL AT ALL EXTERIOR DOORS PER IRC R311.3.
- 5. 36" MIN. HEIGHT GUARDRAIL W/ 4" MAX VERTICAL SPACING OF HORIZONTAL RUNGS. GUARDRAIL TO SUPPORT 200# CONCENTRATED LOAD / 50# UNIFORM LOAD PER 2018 IRC
- 6. PROVIDE CONTINUOUS 1-1/2" DIA. HANDRAIL @ 36" A.F.F. PER IRC R311.7.
- 7. STAIR RISER HEIGHT SHALL BE A MAXIMUM OF 7-3/4" MEASURED VERTICALLY BETWEEN LEADING EDGES OF ADJACENT TREADS PER IRC R311.7.
- 8. OPEN RISERS CANNOT PERMIT THE PASSAGE OF A 4" SPHERE BETWEEN TREADS PER IRC R311.7.
- 9. MIN. STAIR TREAD DEPTH IS 10" MEASURED HORIZONTALLY BETWEEN VERTICAL PLANES OF THE FOREMOST PROJECTION
- OF ADJACENT TREADS PER IRC R311.7. 10. PROFILE OF TREAD: RADIUS OF LEADING EDGE OF TREAD SHALL BE NO GREATER THAN 9/16. A NOSING NOT LESS THAN

3/4 BUT NOT MORE THAN 1 1/4 SHALL BE PROVIDED ON

- STAIRWAYS WITH SOLID RISERS PER IRC R311.7. 11. GAS FIREPLACE INSTALL PER IRC R1004 AND R1005 COMBUSTION AIR PROVIDED PER IRC R1006. REFER TO FIREPLACE SPECS ON SHEET A503.
- 12a. METAL ROOF SCUPPER W/ DOWNSPOUT
- 12b. 4" X 6" MIN. THRU-WALL SCUPPER.
- 13. TANKLESS GAS WATER HEATER. SEE PLUMBING.
- 14. HEAT PUMP. SEE MECHANICAL.
- **15.** TRASH / RECYCLING BINS.
- **16.** GAS METER. SEE PLUMBING.
- 17. 400 AMP ELECTRICAL PANEL. SEE ELECTRICAL.
- 18. AIR HANDLER. SEE MECHANICAL
- 19. SOFT WATER LOOP.
- 20. WATER SOFTENER EQUIPMENT. 21. 4" DIAMETER CONDUIT FROM ELECTRICAL PANEL TO ROOF
- FOR FUTURE SOLAR ARRAY. SEE ELECTRICAL.
- 22. 2" FLOOR DRAIN W/ LEADER DOWN TO LOWER LEVEL. NOT TO BE CONNECTED TO SEWER SYSTEM.
- 23. INTERNAL GUTTER.
- **31.** WATERPROOF DECKING SYSTEM ICC-ES REPORT ESR-2201.
- **42.** POLY-DECK 150 PER ICC-ES REPORT ESR-2785 W/ LOW-PROFILE PEDESTAL LEVELING SYSTEM.
- **44.** DECORATIVE 2"X6", OR SIMILAR, HEMLOCK SHADE FINS.

FLOOR PLAN LEGEND

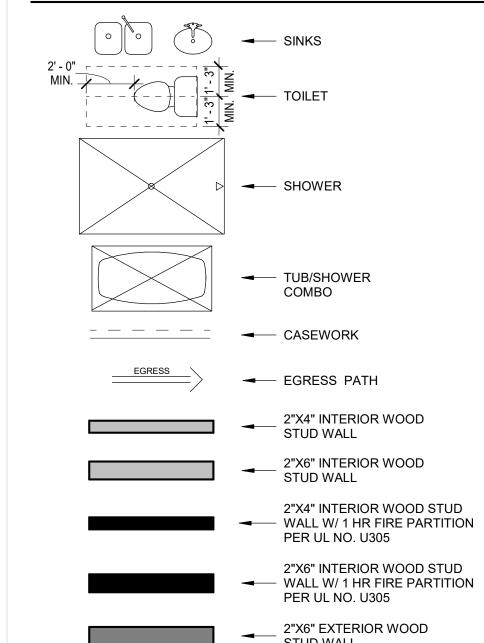


NOTES:

- ALL WOOD FRAMED EXTERIOR WALLS TO HAVE MIN. R-21 INSULATION TYP. ALL CEILINGS TO HAVE MIN. R-38 INSULATION TYP.
- 90% OF LAMPS IN PERMANENT FIXTURES OR 90% OF PERMANENT FIXTURES HAVE HIGH EFFICACY LAMPS. DOES NOT APPLY TO LOW VOLTAGE LIGHTING

STUD WALL

CLOTHES DRYERS TO HAVE BOTH GAS AND ELECTRIC HOOKUP OPTIONS. REFERENCE SHEET P103 AND E104.

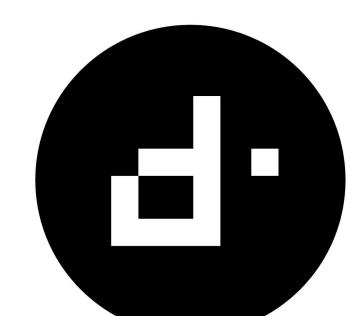

DESIGN**TANK** ©

1640 E BETHANY HOME ROAD PHOENIX, AZ 85016 503.580.5626

CONSULTANT:

PERMIT SET

REASON FOR ISSUE



FLOOR PLAN -LEVEL 2

REVISION 2022-0914 HEET NUMBER 1/4" = 1'-0"

SHEET SIZE

30" X 42"