
212 1 2' - 8" 8' - 0" 213 1 6' - 0" 8' - 0"

214 1 3' - 0" 8' - 0"

WINDOW SCHEDULE							
Mark	Qty.	Window Type	Width	Height	Head Height	Comments	
88	1	Fixed	1' - 4"	5' - 0"	8' - 0"		
В	1	Window-Casem ent-Single_Righ t	3' - 0"	5' - 6"	9' - 0"		
С	11	Fixed	2' - 0"	3' - 0"	<varies></varies>		
D	5	Fixed	1' - 6"	2' - 0"	8' - 0"		
F	2	Fixed	3' - 0"	5' - 0"	7' - 0"		
GT	1	Fixed	5' - 0"	5' - 0"	8' - 0"	tempered	
М	3	Window-Casem ent-Single_Righ t	3' - 0"	5' - 0"	<varies></varies>		
N	1	Fixed	2' - 0"	3' - 6"	7' - 0"		
Р	3	Window-Casem ent-Single_Left	3' - 0"	5' - 0"	7' - 0"		
Q	1	Fixed	1' - 6"	3' - 0"	8' - 0"		
TT	1	Fixed	1' - 6"	3' - 0"	8' - 0"	tempered	
Х	1	Fixed	3' - 6"	6' - 0"	5' - 0"	-	
Υ	1	Fixed	3' - 6"	2' - 0"	19' - 0"		

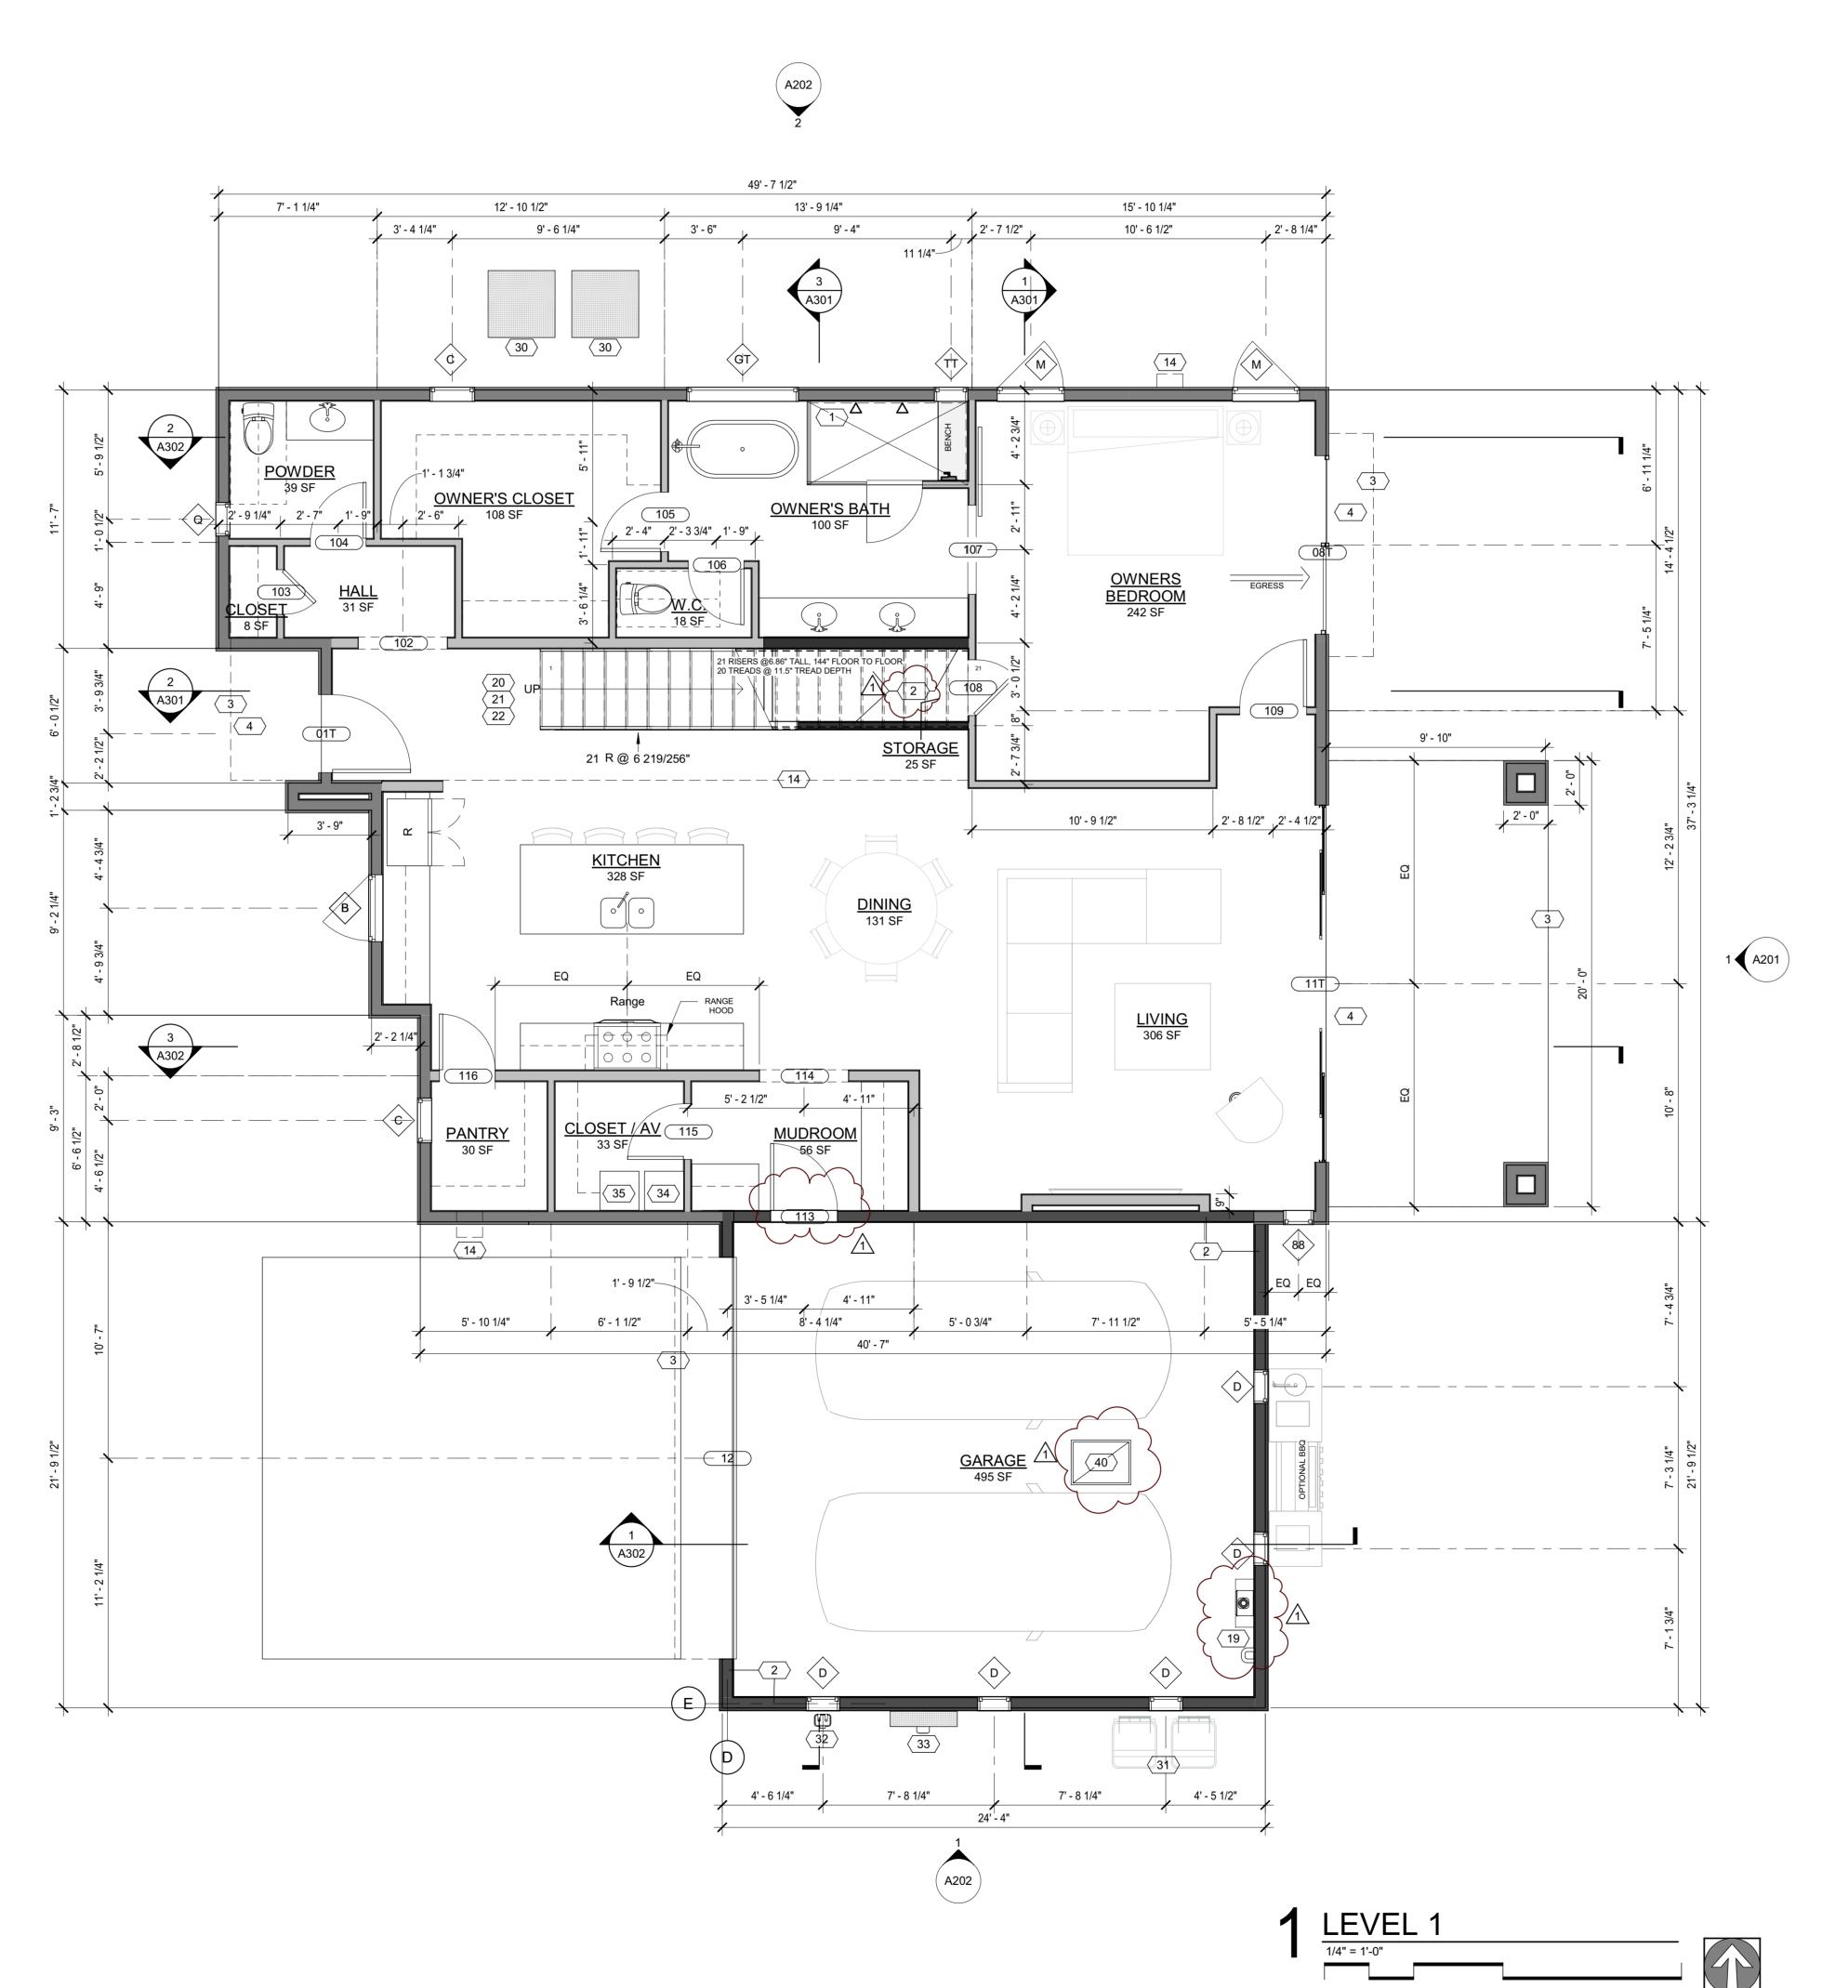

FLOOR PLAN GENERAL NOTES:

1.GAS I

GAS PIPING PLACED UNDER ANY CONCRETE SLAB SHALL COMPLY PER UPC 1210.1.6. REQUIREMENTS.

SHALL CONFORM TO U.P.C. CHAPTER 12 FOR

2. RANGES AND COOKTOPS:
Provide a listed and approved range and/or cooktop unit installed in accordance with the listing and with the manufacturer's installation instructions.

MATERIALS, INSTALLATION, AND TESTING.

3. VERIFY AND MAINTAIN REQUIRED HORIZONTAL AND VERTICAL CLEARANCES ABOVE THE FINISHED COUNTERTOP SURFACE BEFORE ORDERING OR INSTALLING CABINETS.


4. MAXIMUM STUD SPACING IS 16 INCHES ON CENTER UNLESS NOTED OTHERWISE

5. REFER TO STRUCTURAL DRAWINGS FOR LOCATIONS AND ADDITIONAL REQUIREMENTS FOR LOAD-BEARING AND SHEAR WALLS

6. TYPICAL GYPSUM SHEATHING THICKNESS IS 5/8 INCH UNLESS NOTED OTHERWISE

7. SEE DETAIL 9 ON A110 FOR STUCCO SYSTEM ASSEMBLY

FLOOR PLAN LEGEND

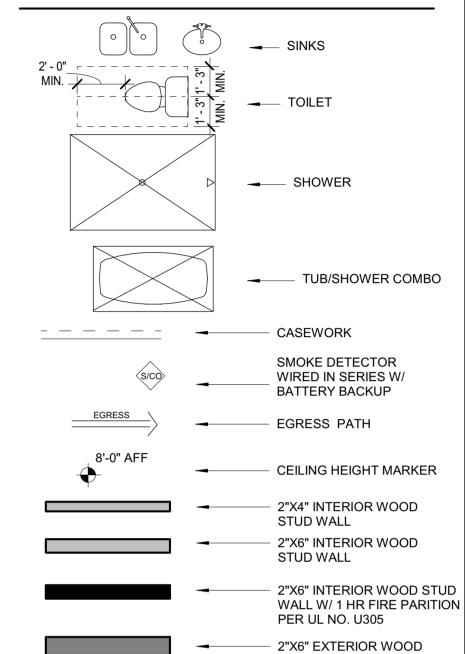

STUD WALL

NOTE:
ALL WOOD FRAMED EXTERIOR WALLS
TO HAVE AIR IMPERMEABLE SPRAY
FOAM INSULATION R-21 MIN. TYP.

ALL CEILINGS TO HAVE AIR
IMPERMEABLE SPRAY FOAM

INSULATIONR-38 MIN. TYP.

NOTE:
90% OF LAMPS IN PERMANENT
FIXTURES OR 90% OF PERMANENT
FIXTURES HAVE HIGH EFFICACY
LAMPS. DOES NOT APPLY TO LOW
VOLTAGE LIGHTING

KEYNOTES

- PROVIDE TILE SURFACE AT WALLS SHOWN WITH BOLD DASHED LINE PER IRC R708.2. TILE SURFACE SHALL EXTEND A MINIMUM OF 6 FEET ABOVE FINISHED FLOOR HEIGHT
 PROVIDE 1-RATED WALL ASSEMBLY AS NOTED REFER TO RATED WALL ASSEMBLY DETAIL 9 ON SHEET A502.
 OVERHANG ABOVE OF FLOOR/ROOF
- 4 ALL WEATHER LANDING SURFACE EQUAL IN WIDTH TO THE DOOR SERVED AND MIN. 36 DEEP IN DIRECTION OF TRAVEL AT ALL EXTERIOR DOORS PER IRC R311.3

WATER LOOP. TANKLESS WATER HEATER

MINIMUM CLEARANCE 6 FT ABOVE FINISH FLOOR

20 36 MIN HEIGHT GAURDRAIL W/ 4/MAX VERTICAL SPACING OF HORIZONTIAL RUNGS. GAURDRAIL TO SUPPORT 200# CONCENTRATED LOAD / 50# UNIFORM LOAD


21 OPEN RISERS CANNOT PERMIT THE PASSAGE OF A 4 SPHERE BETWEEN

19 TANKLESS WATER HEATER AND SOFT

- TREADS.

 22 PROFILE OF TREAD: RADIUS OF LEADING EDGE OF TREAD SHALL BE NO GREATER THAN 9/16. A NOSING NOT LESS THAN 3/4 BUT NOT MORE THAN 1 1/4 SHALL BE PROVIDED ON STAIRWAYS WITH SOLID
- RISERS.

 30 HEAT PUMP SEE MECH.
- 31 TRASH/RECYCLING BINS
 32 GAS METER SEE PLUMBING
- 32 GAS METER, SEE PLUMBING33 ELECTRICAL PANEL, SEE ELEC.
- 34 AIR HANDLER, SEE MECH.
 35 AV RACK 20"X20"
 40 ATTIC ACCESS PANEL MIN 22"X30" PER IRC

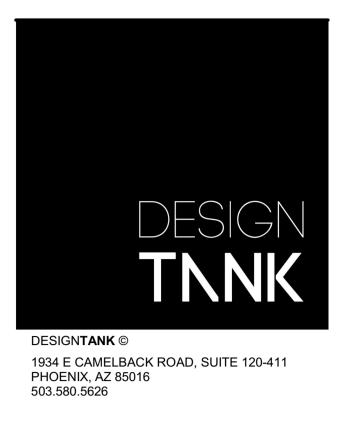

AZUL LOT 1

REVISION DATE REASON FOR ISSUE 1 02/22/2022 City Comments



FIRST FLOOR PLAN
AND SCHEDULES

PERMIT SET

	DATE 2021-09-28	REVISION 1	
-	PROJECT NUMBER 000000	SHEET NUMBER	
	SCALE As indicated	A IU	

10' - 4 3/4"

13' - 10"

27' - 3 1/4"

4' - 11 1/2"

11' - 11 1/4"

3-1-1-

BED 4 146 SF

9' - 10"

14' - 5 1/4"

4' - 4 1/4"

3' - 6 1/2"

CEILING VAULT: SEE A107 4' - 5" 5' - 0"


4' - 6 1/4"

8' - 7 3/4"

KEYNOTES

- VERTICAL SPACING OF HORIZONTIAL RUNGS. GAURDRAIL TO SUPPORT 200# CONCENTRATED LOAD / 50# UNIFORM LOAD
- 24 FOAM ROOF PER ICC-ESR REPORT ESR-2532
- **34** AIR HANDLER, SEE MECH.



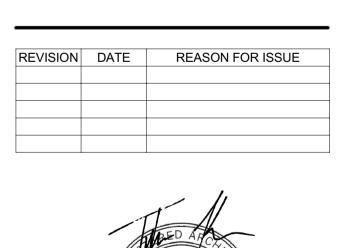

TNNK

1934 E CAMELBACK ROAD, SUITE 120-411

DESIGN**TANK** ©

503.580.5626

PHOENIX, AZ 85016

EXPIRES 09/30/2023

PERMIT SET

DATE 2021-09-28 PROJECT NUMBER 000000

OutputOutput

Date: 03/24/22

FLOOR PLAN **GENERAL NOTES:**

 1.GAS LINES:
 GAS PIPING PLACED UNDER ANY CONCRETE SLAB SHALL COMPLY PER UPC 1210.1.6.

 STATEMENTS SHALL CONFORM TO U.P.C. CHAPTER 12 FOR MATERIALS, INSTALLATION, AND TESTING.

2. RANGES AND COOKTOPS: Provide a listed and approved range and/or cooktop unit installed in accordance with the listing and with the manufacturer's instructions.

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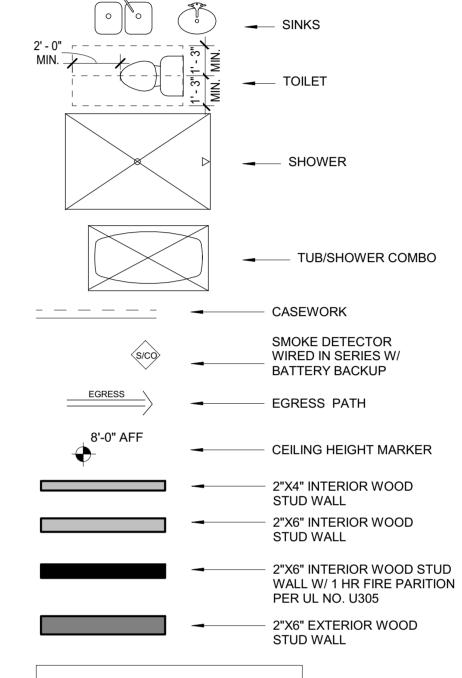
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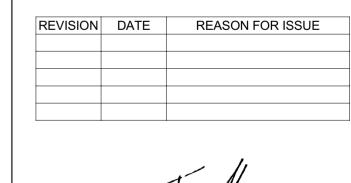
FLOOR PLAN LEGEND



ALL WOOD FRAMED EXTERIOR WALLS TO HAVE AIR IMPERMEABLE SPRAY FOAM INSULATION R-21 MIN. TYP. ALL CEILINGS TO HAVE AIR IMPERMEABLE SPRAY FOAM INSULATIONR-38 MIN. TYP.

90% OF LAMPS IN PERMANENT FIXTURES OR 90% OF PERMANENT FIXTURES HAVE HIGH EFFICACY LAMPS. DOES NOT APPLY TO LOW **VOLTAGE LIGHTING**

- **14** ROOF SCUPPER
- **20** 36 MIN. HEIGHT GAURDRAIL W/ 4 MAX
- **26** ASPHALT SHINGLE ROOF PER ICC-ESR





SECOND FLOOR PLAN

SCALE
As indicated

03/24/22

A302

CEILING VAULT: SEE A107

14

4' - 8"

A302

213

3' - 9" 3' - 4"

11' - 2"

14' - 0 1/4"

(E)/

3' - 6 1/4" 2' - 1 1/4"

2' - 9" 4' - 8 1/2"

35' - 11"